
ALL WATER INSTALLATIONS TO COMPLY WITH IRISH WATER CONNECTION AND DEVELOPER SERVICES WATER INFRASTUCTURE STANDARD DETAILS

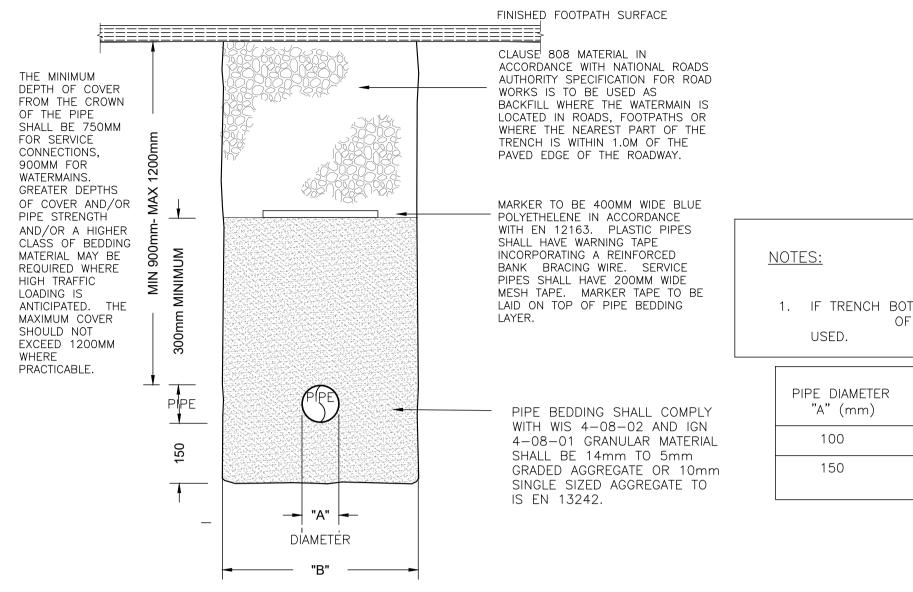



DEPTH OF REINSTATED TOPSOIL TO MATCH EXISTING THE MINIMUM DEPTH OF COVER FROM THE CROWN OF THE PIPE SHALL BE 750MM FOR SERVICE CONNECTIONS, 900MM FOR WATERMAINS. GREATER DEPTHS OF COVER AND/OR PIPE STRENGTH AND/OR A HIGHER SELECTED EXCAVATED MATERIAL MAY CLASS OF BEDDING MATERIAL MAY BE BE USED IN GREEN FIELD AREAS REQUIRED WHERE HIGH TRAFFIC LOADING IS ABOVE GRANULAR PIPE SURROUND ANTICIPATED. THE MAXIMUM COVER SHOULD MATERIAL SUBJECT TO THI APPROVAL OF IRISH WATER. NOT EXCEED 1200MM WHERE PRACTICABLE. MARKER TO BE 400MM WIDE BLUE POLYETHELENE IN ACCORDANCE WITH EN 12163. PLASTIC PIPES SHALL HAVE WARNING TAPE INCORPORATING A REINFORCED BANK BRACING WIRE. SERVICE 1. IF TRENCH BOTTOM CONTAINS ROCK, THEN A MINIMUM PIPES SHALL HAVE 200MM WIDE OF A 300mm PIPE BEDDING SHALL BE MESH TAPE. MARKER TAPE TO BE LAID ON TOP OF PIPE BEDDING TRENCH WIDTH PIPE BEDDING SHALL COMPLY "B" (mm) WITH WIS 4-08-02 AND IGN 4-08-01 GRANULAR MATERIAL SHALL BE 14mm TO 5mm 500 GRADED AGGREGATE OR 10mm SINGLE SIZED AGGREGATE TO 600 IS EN 13242.

BEDDING DETAILS ACROSS ROADS & FOOTPATHS


TO IRISH WATER DRAWING STD-W-13.

TYPICAL TRENCH DETAILS (scale 1:20)

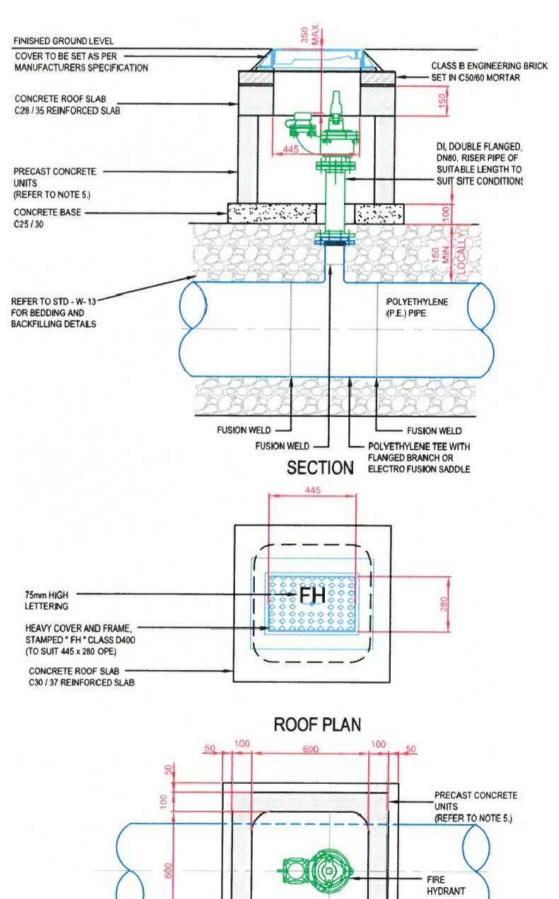


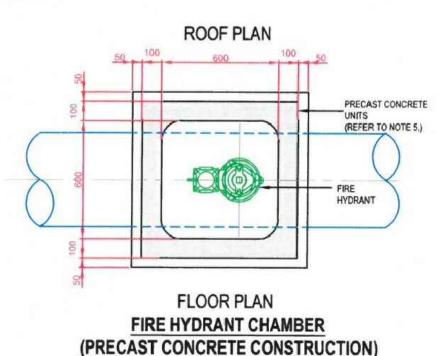

FIRE HYDRANT DETAILS (scale 1:20) TO IRISH WATER DRAWING STD-W-18. FOR CONSTRUCTION DETAIL.

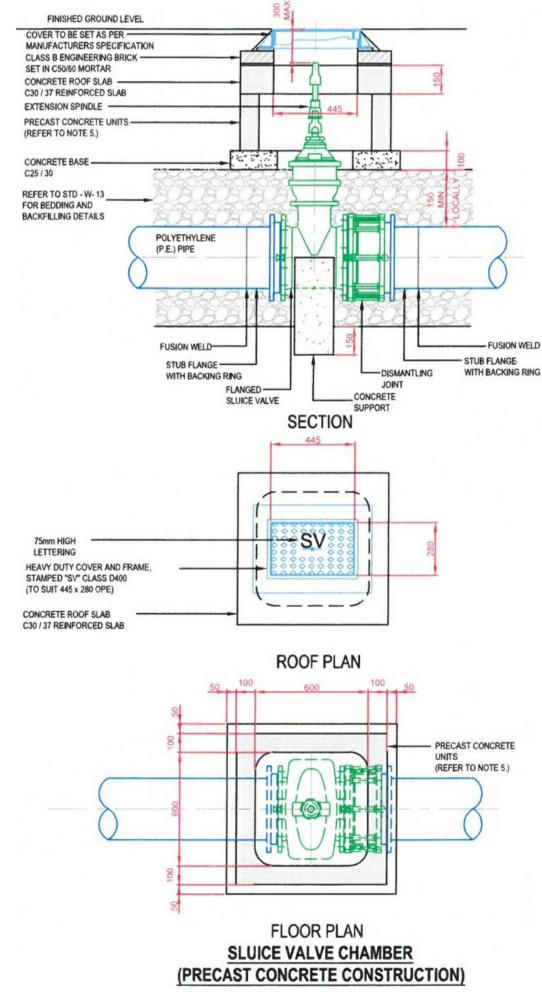


SLUICE VALVE DETAILS (scale 1:20) REFER TO IRISH WATER DRAWING STD-W-15 FOR CONSTRUCTION DETAIL.

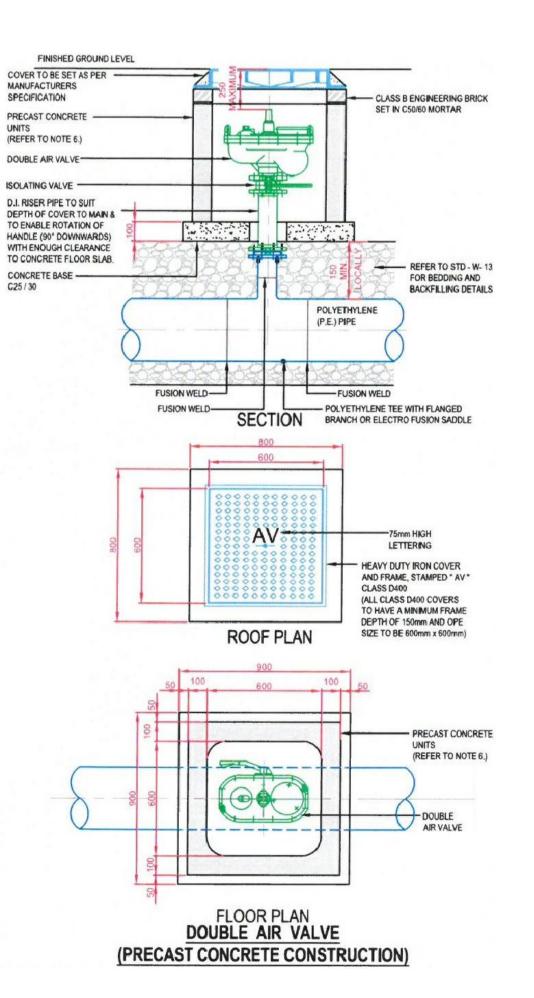

BEDDING DETAILS ACROSS OPEN SPACE


TO IRISH WATER DRAWING STD-W-13.

AIR VALVE DETAILS (scale 1:20) REFER TO IRISH WATER DRAWING STD-W-22 FOR CONSTRUCTION DETAIL.

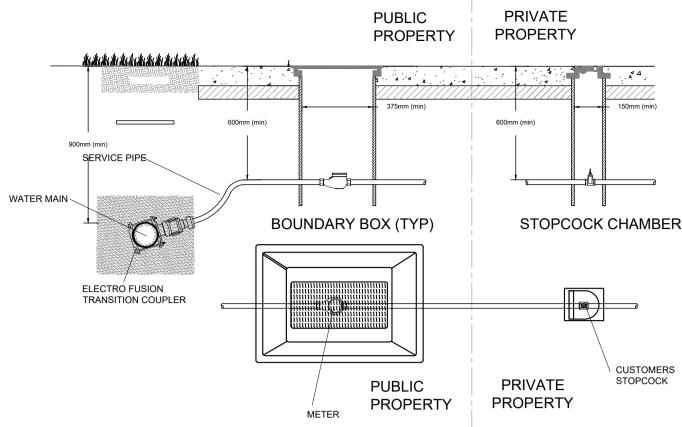

TYPICAL HOUSE CONNECTION (NTS)

TO IRISH WATER DRAWING STD-W-01 & 03.

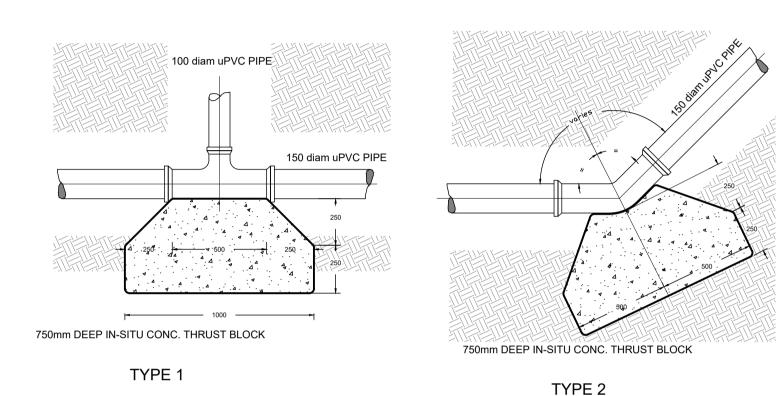

THRUST BLOCK DETAILS (scale 1:20)

TO IRISH WATER DRAWING STD-W-28.

HEAVY DUTY COVER AND FRAME, STAMPED " Me " -COVER TO BE SET AS PER MANUFACTURERS SPECIFICATION CLASS D400 TO IS EN 124 (TO SUIT 900 SQ. OPE) CONCRETE ROOF SLAB C30 / 37 REINFORCED SLAB 1 No. MIN. OR 3 No. COURSES MAX.OF CLASS B MANHOLE STEPS TO COMPLY WITH IS EN 1310 , TYPE D, CLASS 1, GALVANISED MILD STEEL & PLASTIC ENCAPSULATED D.I. PLAIN ENDED PIPE WITH THRUST FLANGE FLEXIBLE COUPLING PLAIN ENDED PIPE (CUT TO SUIT) THICKENED FLOOR T CONCRETE CAS SECTION CAST-IN RECESSED LIFTING EYES STAMPED " Me " CLASS D400 TO IS EN 124 (TO SUIT 900 SQ. OPE) 3 No. COURSES MAX.OF CLASS B ENGINEERING BRICKWORK SET IN C50/60 MORTAR PE TO DI DETAIL **ROOF PLAN**

> METER CHAMBER (scale 1:50) REFER TO IRISH WATER DRAWING STD-W-26 FOR CONSTRUCTION DETAIL.


FLOOR PLAN

TO BE INSTALLED

WITH DRAW CORD (REFER TO STD-W-36) DUCT END TO BE SEALED

TO BE INSTALLED

(REFER TO STD-W-36) DUCT END TO BE SEALED

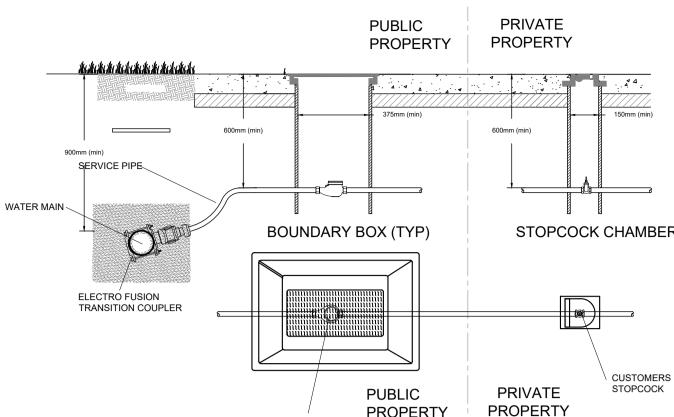

NOTES: ALL WORKS TO COMPLY WITH IRISHWATER CONNECTION AND DEVELOPER SERVICES WATER INFRASTRUCTURE STANDARD DETAILS

- 1. ALL HOUSE CONNECTIONS IN ACCORDANCE WITH DRG. NO. STD-W-03
- 2. GENERAL PIPE CONNECTIONS IN ACCORDANCE WITH DRG. NO. STD-W-05 TO 10 3. SEPERATION DISTANCES IN ACCORDANCE WITH DRG. NO. STD-W-11

The Developer/Contractor/Builder is to ensure that the building under construction/alteration is to comply where applicable with the 2010 Building

Regulations in respect of all trades involved in the

The Developer/Contractor/Builder should notify

BCA of any intended deviations from these plans prior to commencement of development.

All Site Development works to be carried out in

Housing Areas" Dept. of Environment.

'Recommendations for Site Development Works for

Contractors must verify all dimensions at the job

dimensions to be scaled. This drawing is for the

purpose of planning only. Dimensions to blockwork

before commencing any work. No working

construction of this development.


accordance with

4. TRENCH BACKFILLING IN ACCORDANCE WITH DRG. NO. STD-W-13

6. PUSH IN RUBBER RING JOINTS SHALL BE PLACED IN ACCORDANCE WITH MANUFACTURER'S INSTRUCTIONS FOR THE PIPE MATERIAL.

- 5 ALL PIPES TO BE PE WITH PERO PRIPE100 BATING, ALL PIPESSHALL BE BLUE IN COLOUR. HDPE PIPES SHALL BE OF A TYPE PE-80 AND HAVE AN
- SDR-11 OR SDR-17 BATING THEY SHALL CONFORM TO IS EN 12201: PART 1 AND PART 2 (PLASTIC SYSTEMS FOR WATER SUPPLY, DRAINAGE AND
- SEWERAGE LINDER PRESSURE PART 1 GENERAL AND PART 2 PIPES) AND I.S.EN 12201-3 (PLASTIC SYSTEMS FOR WATER SUPPLY, DRAINAGE AND SEWERAGE UNDER PRESSURE -PART 3 FITTINGS).

* * * * * *

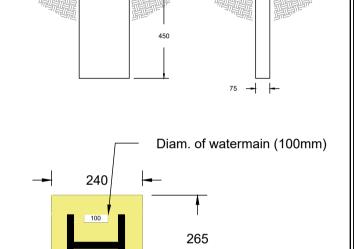

CONCRETE MARKER POST (scale 1:20) TO IRISH WATER DRAWING STD-W-27.

Dist. of marker from hydrant (2m)

Westar Investments Ltd. Clane KDA1 SHD Lands at Capdoo & Abbevlands, Clane, Co. Kildare Drawing Title: SERVICES - Watermain Details

brian connolly associate CONSULTING ENGINEER

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e: bcassoc@eircom.net

(SHEET 2 of 3)

Planning - SHD 02c

As Shown @A drawn by **Brian Connolly** cad ref no planning ref no 18002-303-15